

27 Omaha Street, BELFIELD

Render 1

Manuf: Dulux

Colour: Grey Splendor or eq.

R2

Render 2

Manuf: Dulux

Colour: Vivid White or eq.

CF

Concrete Feature

Manuf: Sarbico

Colour: Concrete or eq.



Natural Stone Clad

Manuf: Stone

Colour: Natural Stone or eq.



Brick Face

Manuf: Austral

Colour: Urban One Silver or eq.



Garage/Entry Door

Manuf: Aluminium

Colour: Silver Tea or eq.



Aluminium slats

Manuf: Aluminium

Colour: Grey Cabin Color or eq.



Roof

Manuf: Colorbond

Colour: Otto's Boy or eq.



Window Frames

Manuf: Aluminum

Colour: Black or eq.



Glass Balustrade

Colour: Clear Anodised.



s y d n e y

Shop 3, 134-136 Woodville Road, Merrylands 2160 P. 8677 9837

m. 0487 434946 (0487 idizin) e. admin@idizin.com.au

PO BOX 604 MERRYLANDS NSW 2160 www.idizin.com.au

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Smoke Alarm to be interconnected with each other in accordance with Part 9.5.2 and 9.5.4 of BCA 2022

| Issue | Amendment | Initials | CCte |
|-------|------------------------|----------|----------|
| А | Issued for DA Approval | A.T | 20.09.24 |
| | | | |
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Address:

27 Omaha Street, BELFIELD, NSW

Project:

Demolition of Existing Structures, Proposed Construction of 2 Storey Dwelling Above Basement, Swimming Pool and Front Fence


Color Schedule

Council:

Canterbury-Bankstown Council

DA DRAWINGS

20.09.24 21-2023 NTS (A1) DA-100

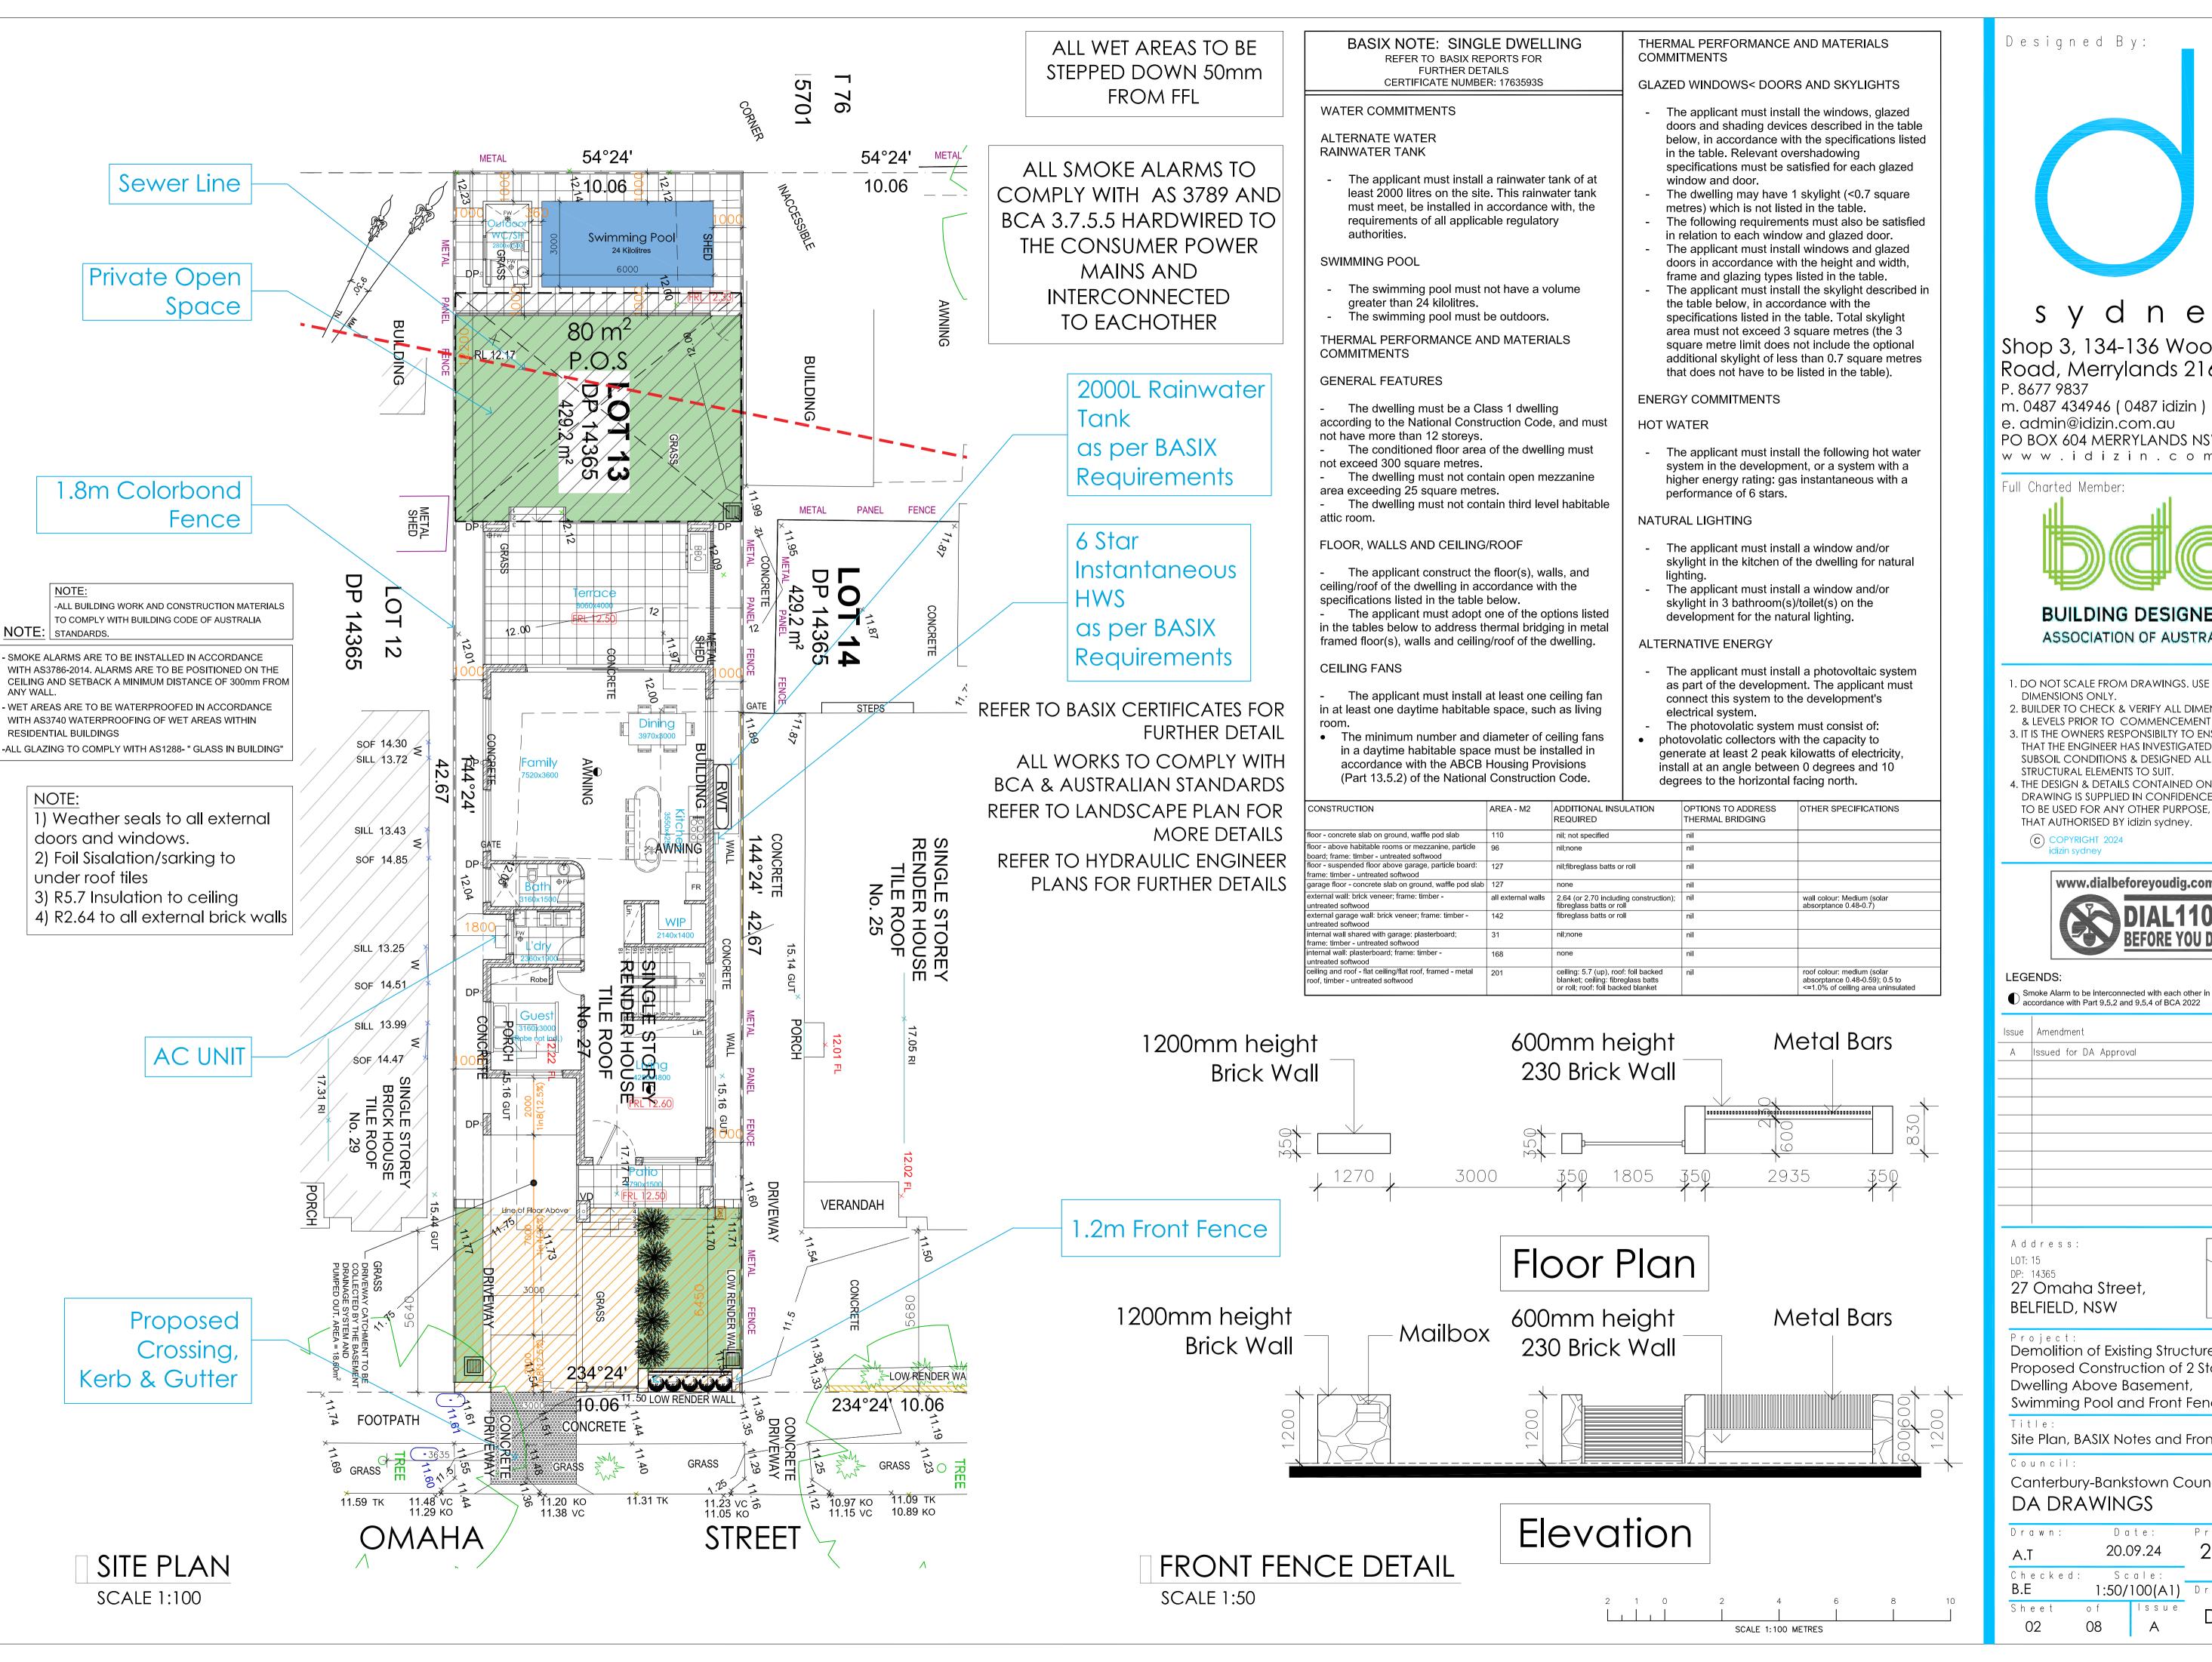



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BELFIELD, NSW




Demolition of Existing Structures, Proposed Construction of 2 Storey Dwelling Above Basement, Swimming Pool and Front Fence

Site Plan, BASIX Notes and Front Fence

Canterbury-Bankstown Council DA DRAWINGS

| Drawn: | rawn: Date: | | Proje | ct No. |
|----------|-------------|---------|--------|--------|
| A.T | 20.09.24 | | 21-2 | 2023 |
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FLOOR AREAS:

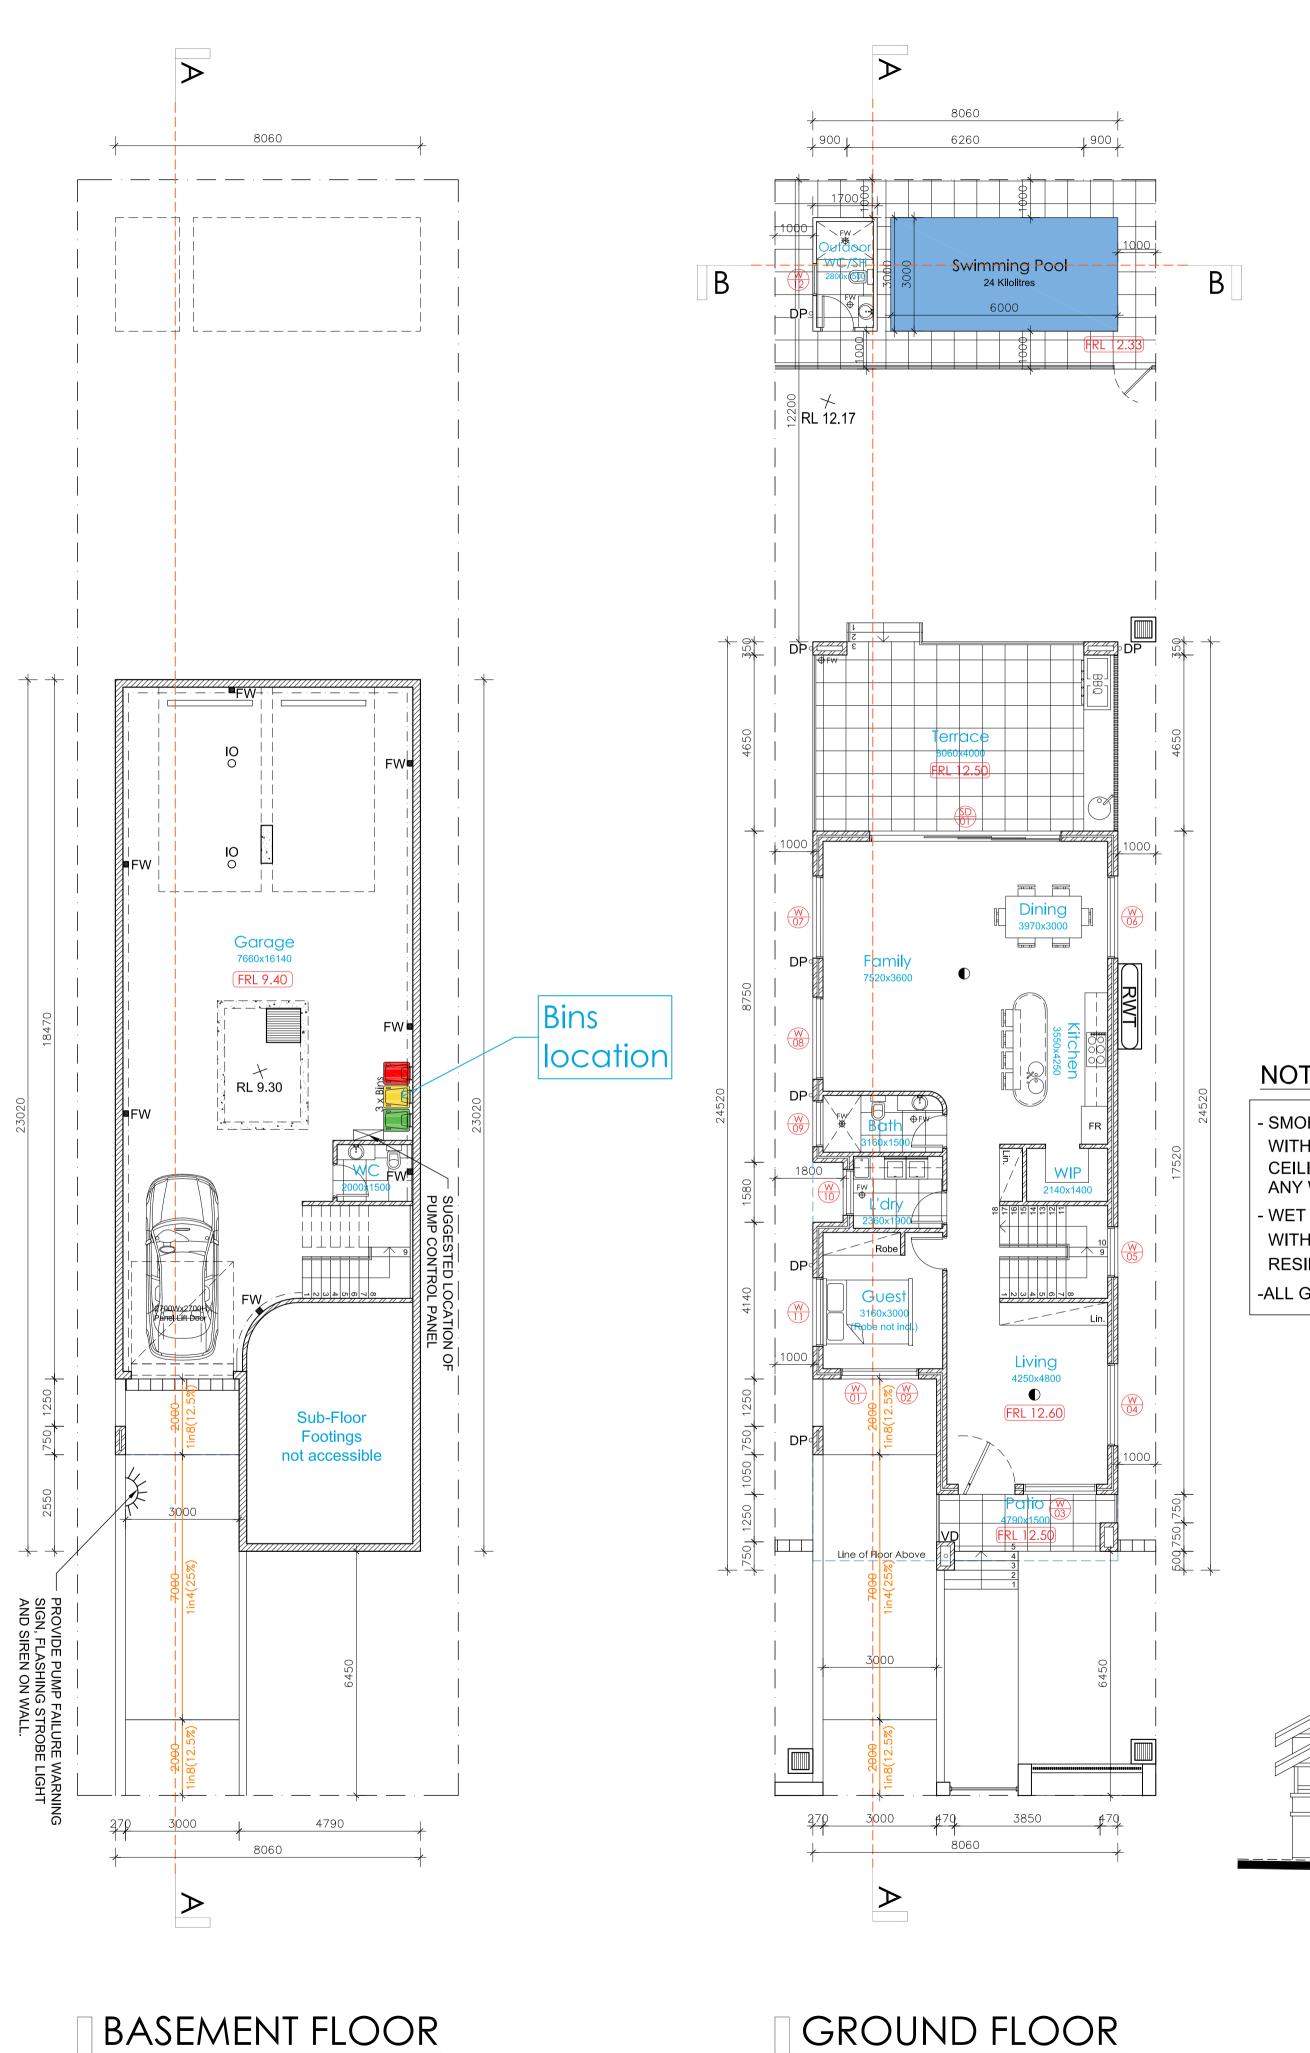 $= 429.2 \text{ m}^2$ SITE AREA

PROPOSED GROUND FLOOR AREA = 116 m² PROPOSED FIRST FLOOR AREA $= 97.75 \text{ m}^2$

MAX. FLOOR AREA REQ. $= 0.5:1= 50\% = 214.60 \text{ m}^2$ PROPOSED FLOOR AREA = $213.75 \text{ m}^2 = 49.8 \%$

REQUIRED PRIVATE OPEN SPACE = 80 m² PROPOSED PRIVATE OPEN SPACE = 132.80 m²

REFER TO BASIX CERTIFICATES FOR FURTHER DETAIL

ALL WORKS TO COMPLY WITH **BCA & AUSTRALIAN STANDARDS** REFER TO LANDSCAPE PLAN FOR MORE DETAILS

REFER TO HYDRAULIC ENGINEER PLANS FOR FURTHER DETAILS

NOTE:

-ALL BUILDING WORK AND CONSTRUCTION MATERIALS TO COMPLY WITH BUILDING CODE OF AUSTRALIA NOTE: | STANDARDS.

- SMOKE ALARMS ARE TO BE INSTALLED IN ACCORDANCE WITH AS3786-2014. ALARMS ARE TO BE POSITIONED ON THE CEILING AND SETBACK A MINIMUM DISTANCE OF 300mm FROM ANY WALL.
- WET AREAS ARE TO BE WATERPROOFED IN ACCORDANCE WITH AS3740 WATERPROOFING OF WET AREAS WITHIN RESIDENTIAL BUILDINGS
- -ALL GLAZING TO COMPLY WITH AS1288- " GLASS IN BUILDING"

ALL SMOKE ALARMS TO COMPLY WITH AS 3789 AND BCA 3.7.5.5 HARDWIRED TO THE CONSUMER POWER MAINS AND INTERCONNECTED TO EACHOTHER

NOTE:

- 1) Weather seals to all external doors and windows.
- 2) Foil Sisalation/sarking to under roof tiles
- 3) R5.7 Insulation to ceiling
- 4) R2.64 to all external brick walls

ALL WET AREAS TO BE STEPPED DOWN 50mm FROM FFL



27 Omaha St.

SCALE 1:100

SCALE 1:100

STREETSCAPE SCALE 1:100

29 Omaha St.



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P. 8677 9837 m. 0487 434946 (0487 idizin) e. admin@idizin.com.au PO BOX 604 MERRYLANDS NSW 2160 www.idizin.com.au

Full Charted Member:



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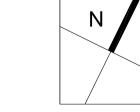
- THAT THE ENGINEER HAS INVESTIGATED SUBSOIL CONDITIONS & DESIGNED ALL
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27 Omaha Street, BELFIELD, NSW




Demolition of Existing Structures, Proposed Construction of 2 Storey Dwelling Above Basement,

Swimming Pool and Front Fence

Floor Plans, Streetscape and Calculations

Canterbury-Bankstown Council DA DRAWINGS

Project No. 21-2023 20.09.24 Scale: 1:100(A1) Draw. No. DA-300

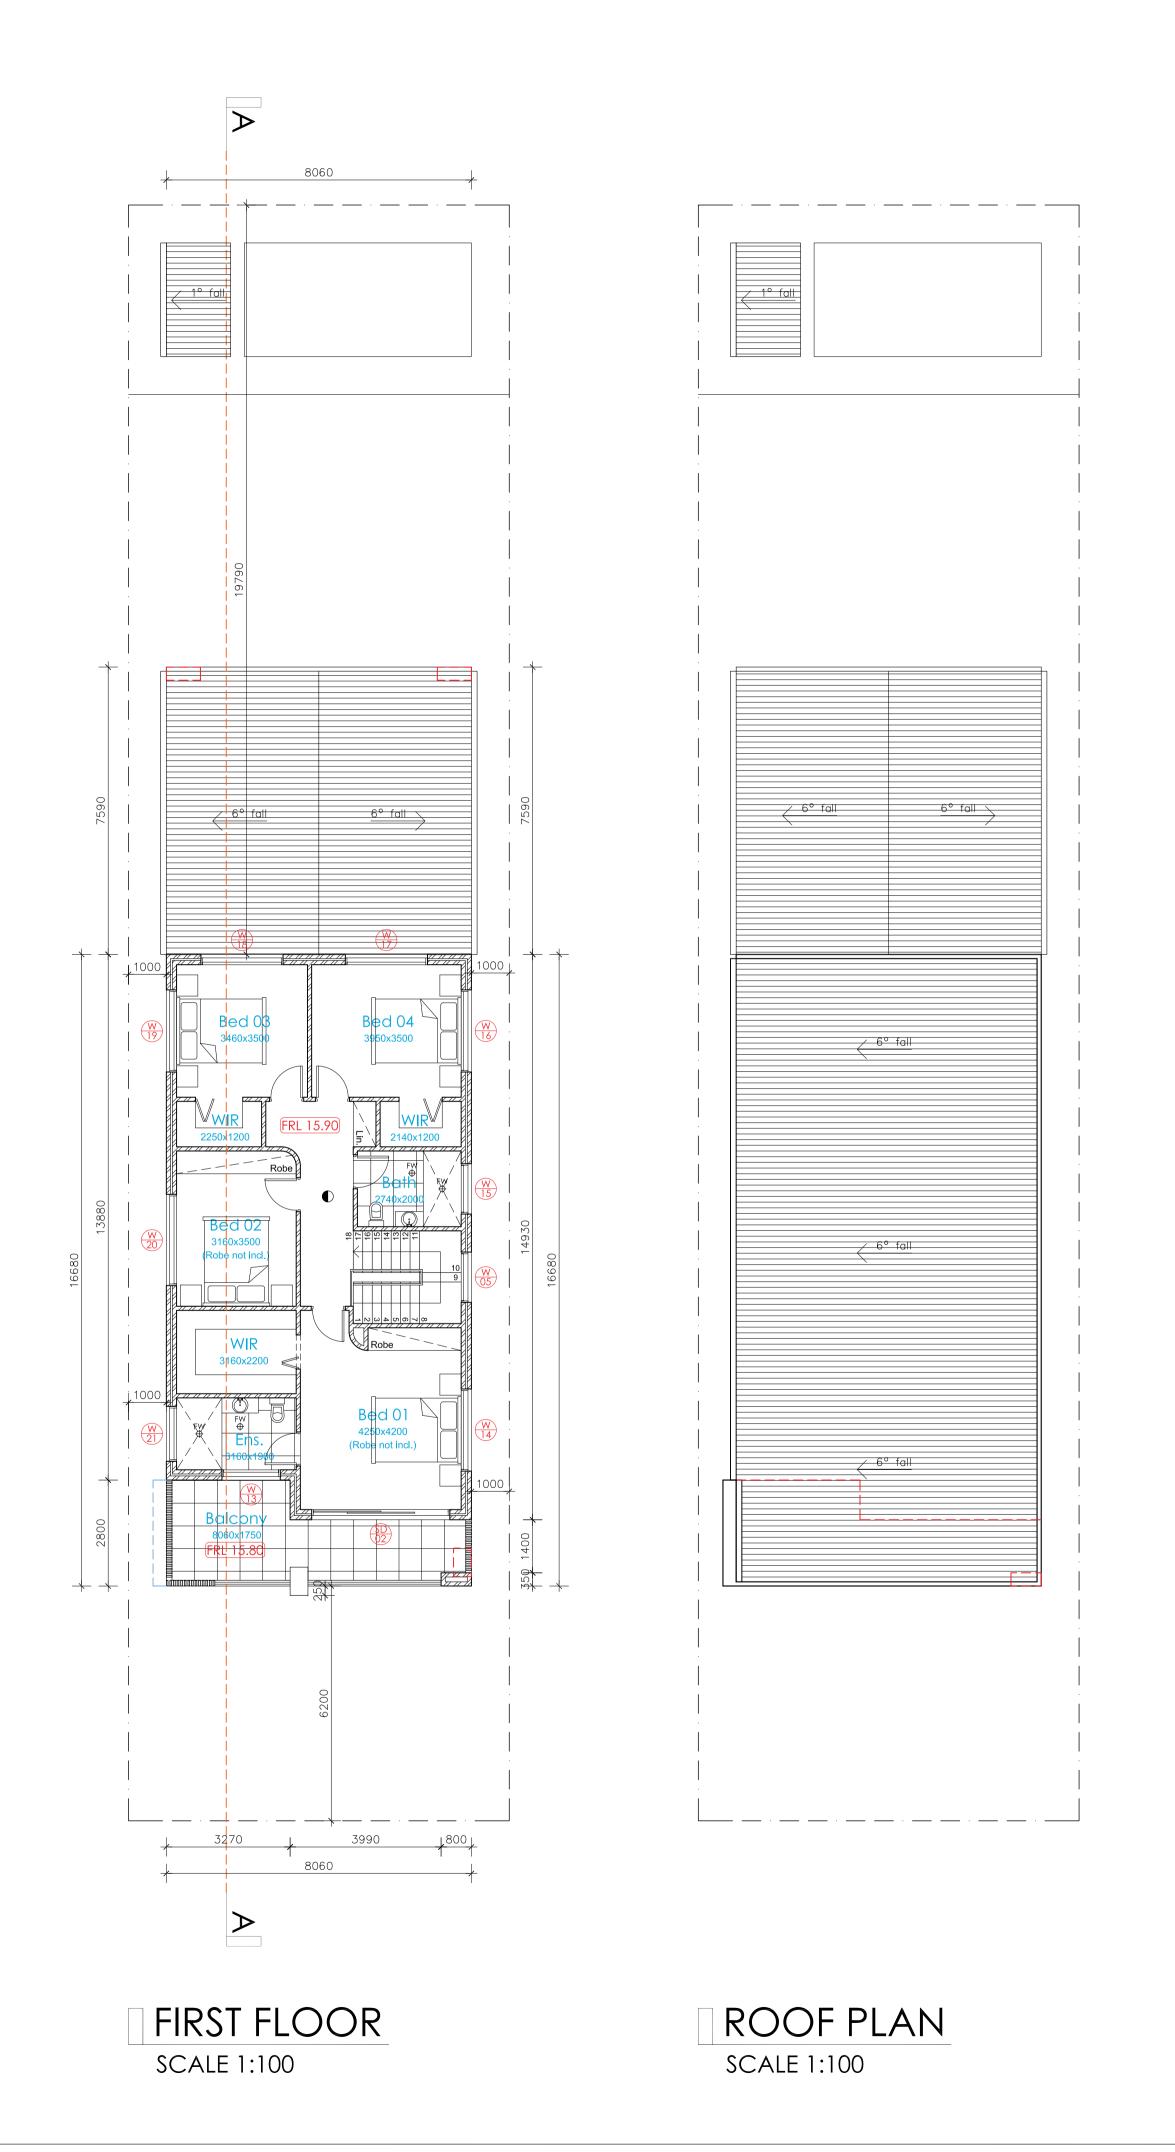

NOTE:

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TO COMPLY WITH BUILDING CODE OF AUSTRALIA
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ALL SMOKE ALARMS TO
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BCA 3.7.5.5 HARDWIRED TO
THE CONSUMER POWER MAINS
AND INTERCONNECTED
TO EACHOTHER

REFER TO BASIX CERTIFICATES FOR FURTHER DETAIL

ALL WORKS TO COMPLY WITH BCA & AUSTRALIAN STANDARDS REFER TO LANDSCAPE PLAN FOR MORE DETAILS

REFER TO HYDRAULIC ENGINEER PLANS FOR FURTHER DETAILS

NOTE:


- 1) Weather seals to all external doors and windows.
- 2) Foil Sisalation/sarking to under roof tiles
- 3) R5.7 Insulation to ceiling
- 4) R2.64 to all external brick walls

PROPOSED AREA: = 101.35 m²

FRONTAGE AREA: = 64.63 m²

MIN FRONTAGE LANDSCAPING 45%: = 29.08 m²

PROPOSED AREA: = 29.90 m²

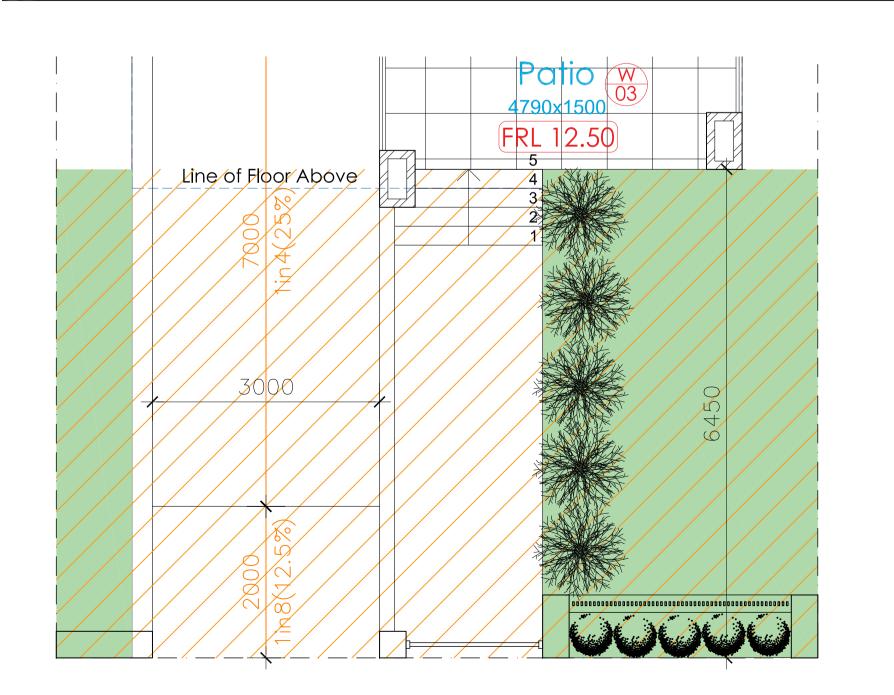

FRONT LANDSCAPE CALCULATION

 Designed By:

O
N
S
y d n e y

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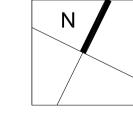


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DP: 14365 27 Omaha Street, BELFIELD, NSW



Project: **Demolitio**n

Demolition of Existing Structures, Proposed Construction of 2 Storey Dwelling Above Basement, Swimming Pool and Front Fence

Title: First Floor Plan, Roof Plan and Landscape Calculation

Council:


Canterbury-Bankstown Council
DA DRAWINGS


Drawn: Date: Project No.

A.T 20.09.24 21-2023

Checked: Scale:
B.E 1:50/100(A1)

Sheet of Issue DA-301

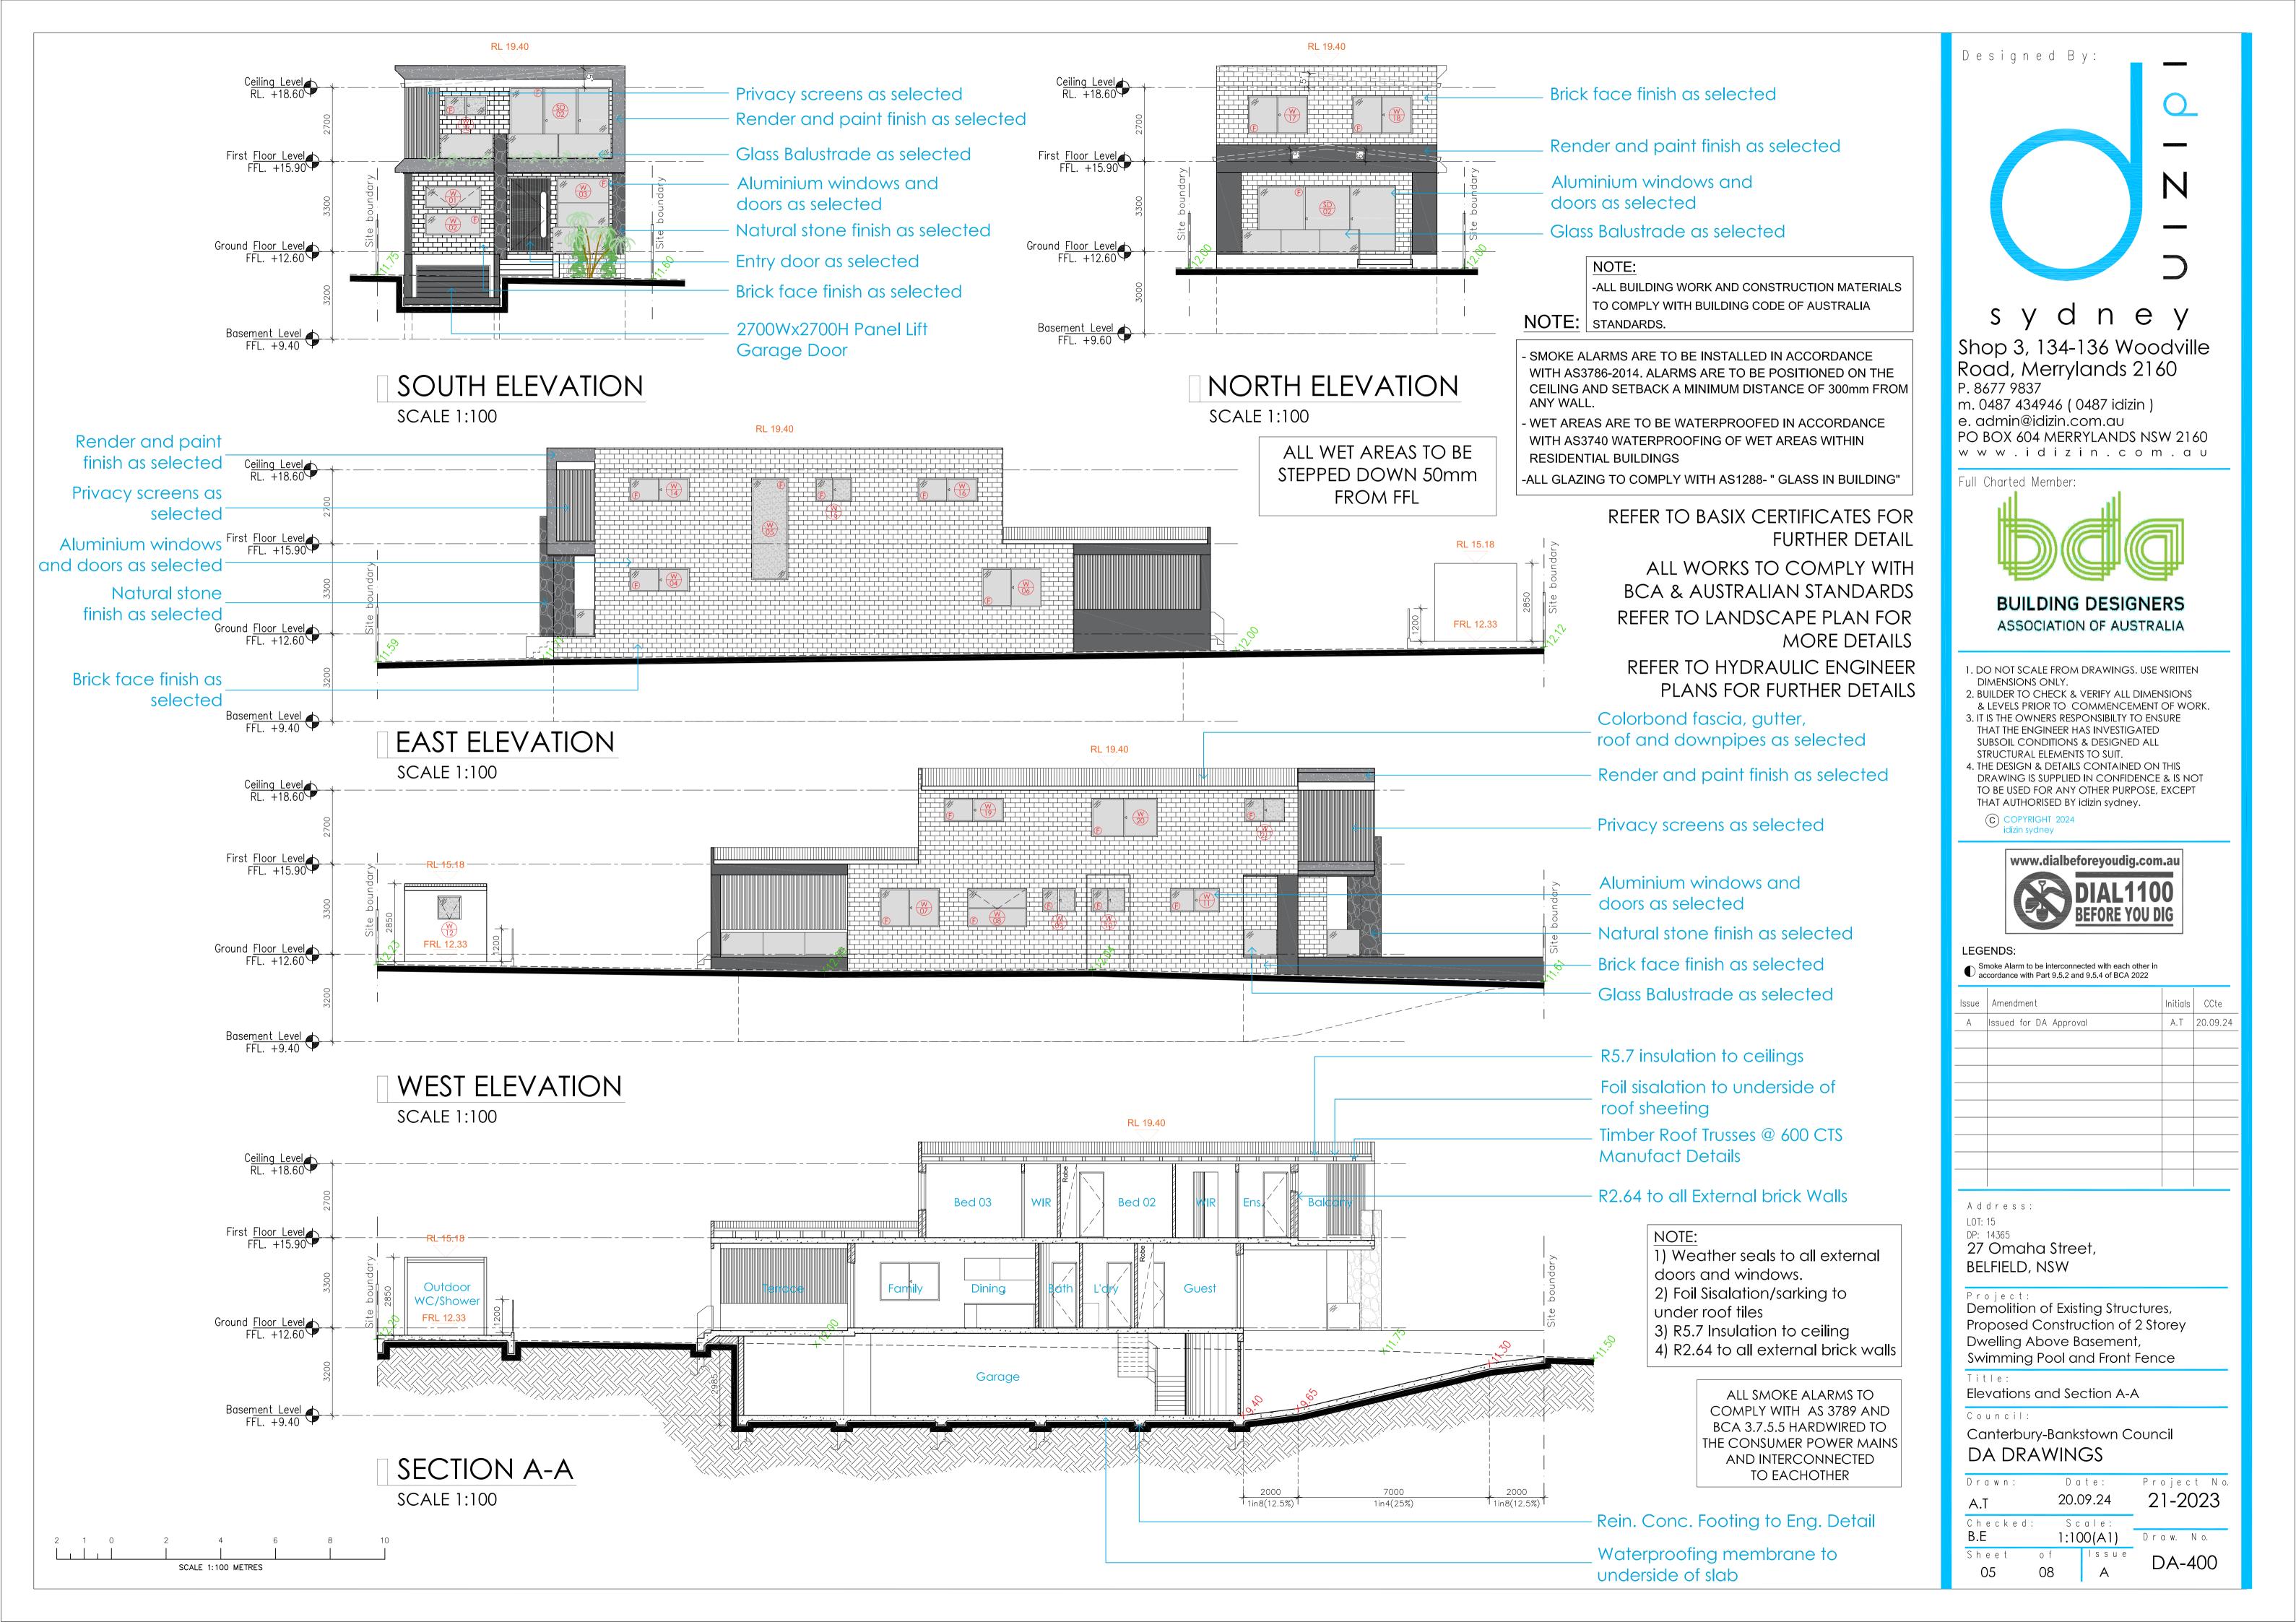

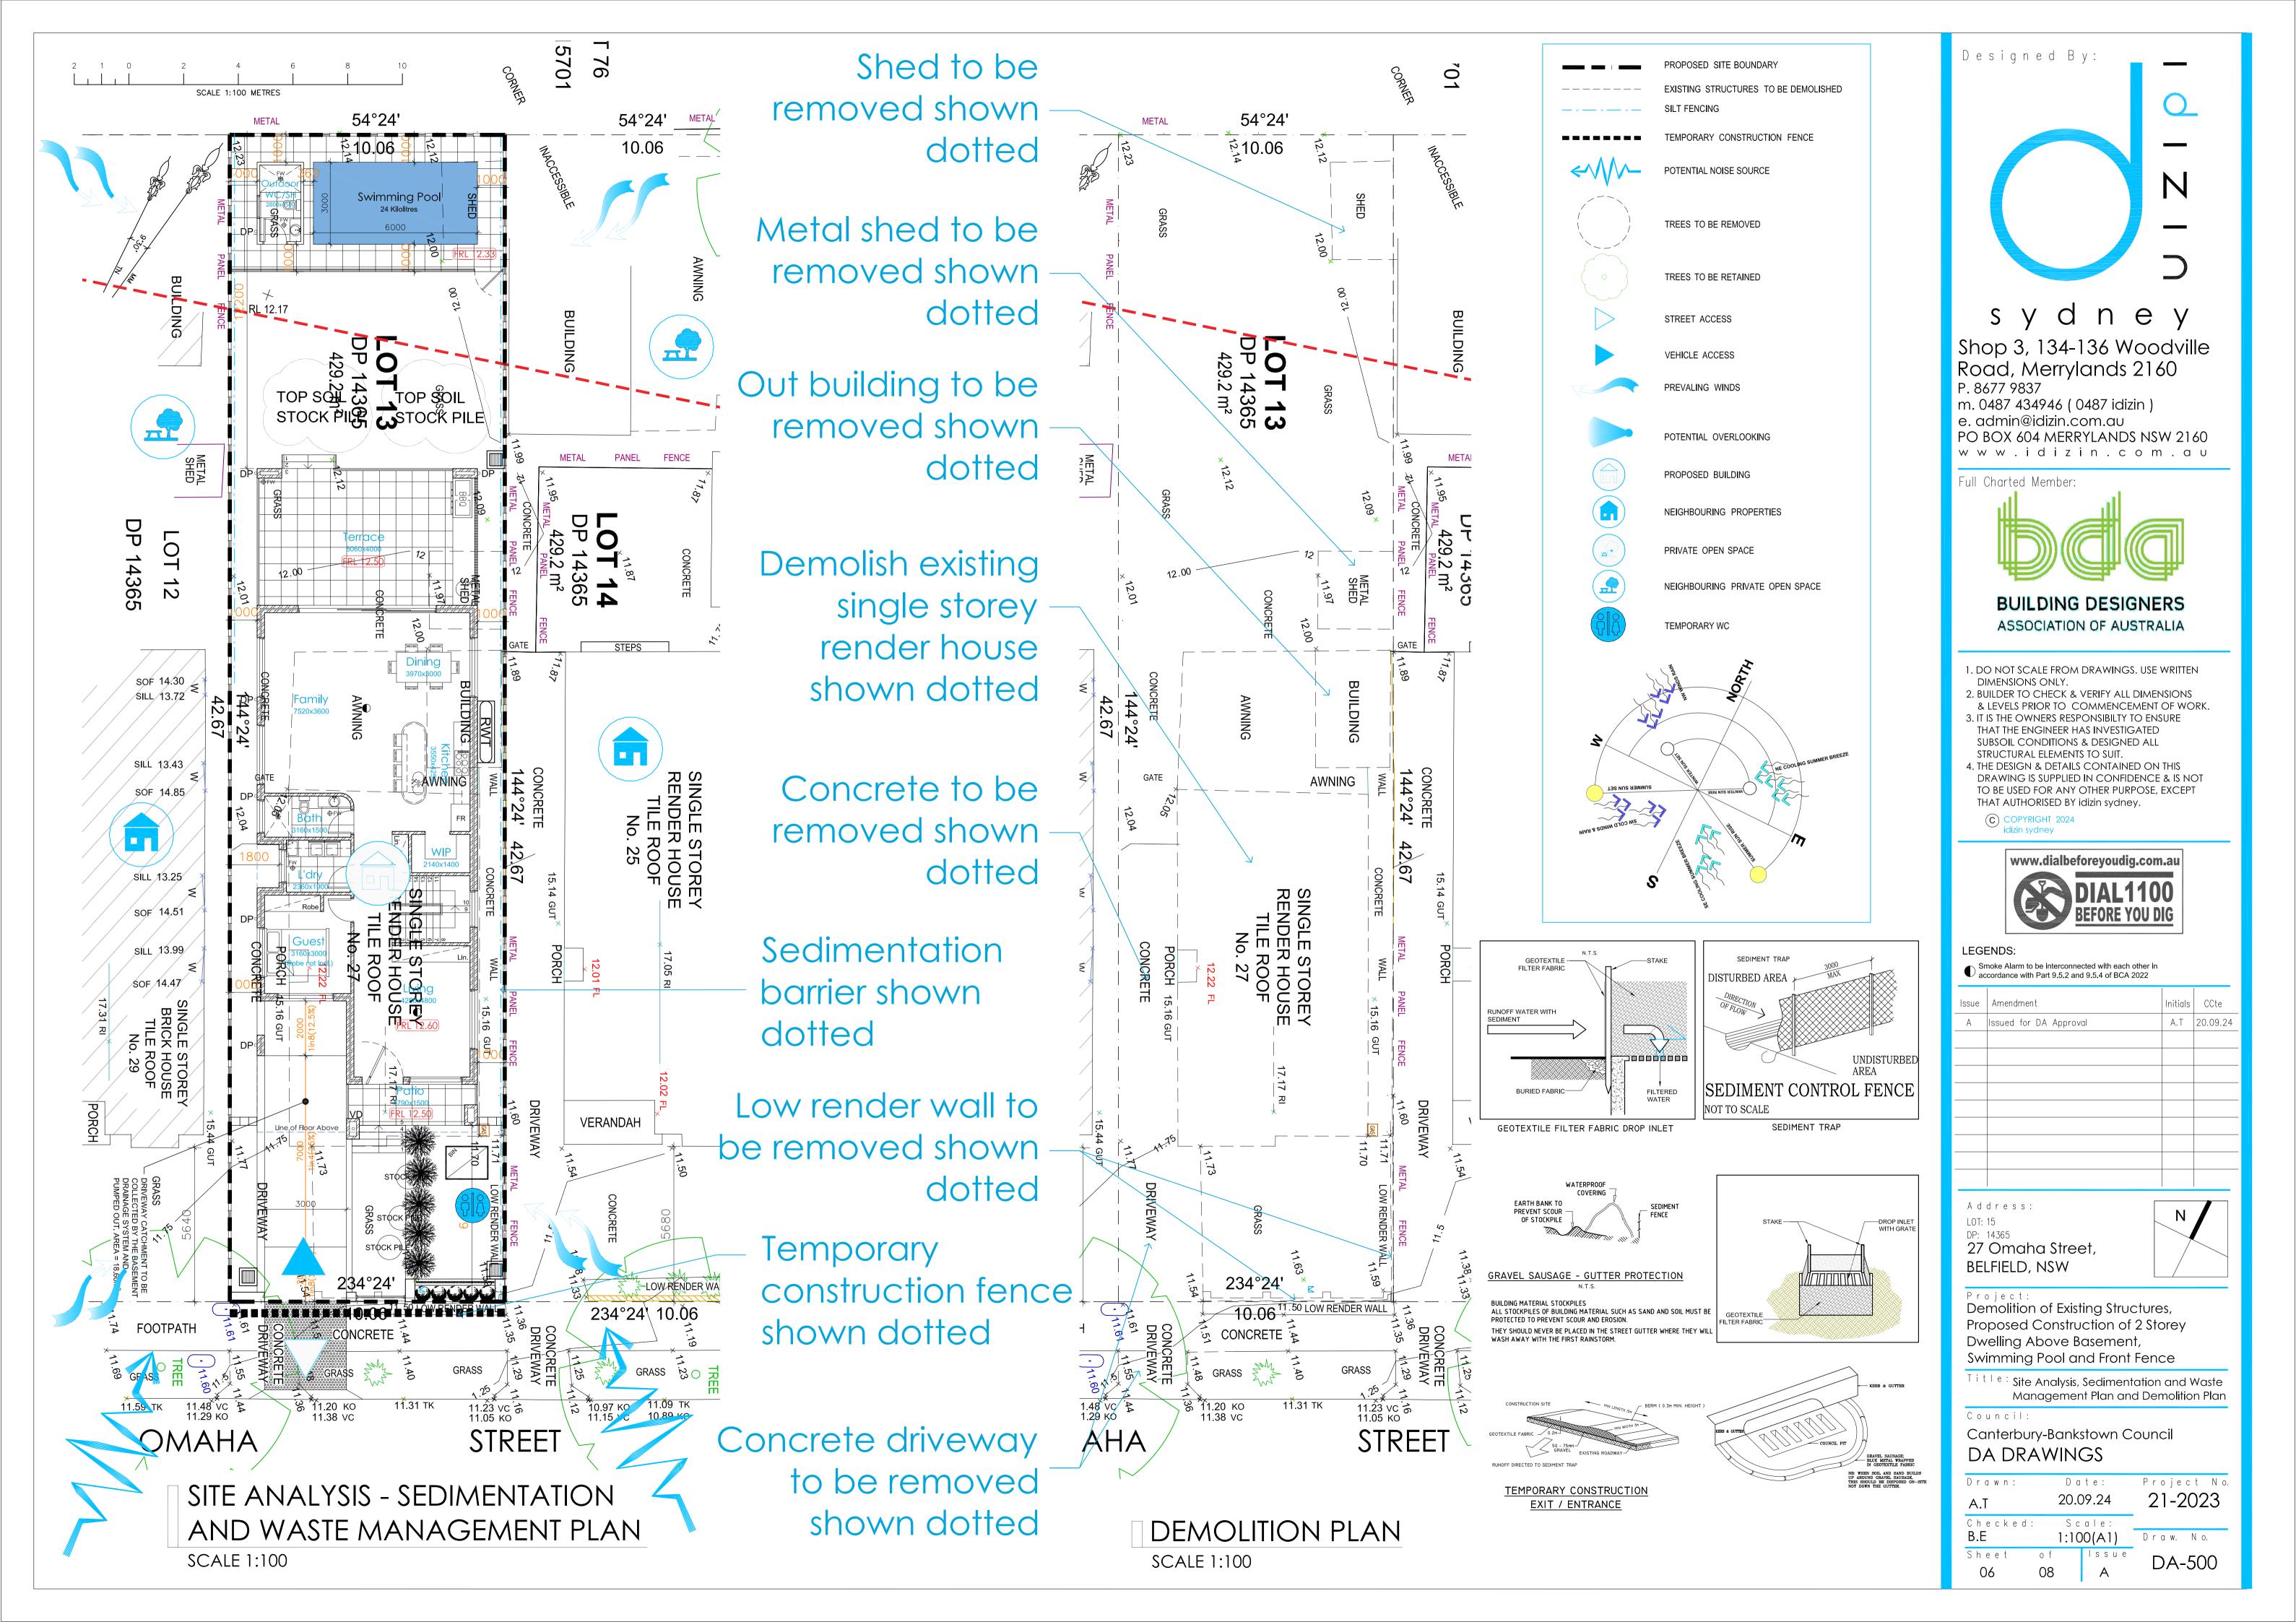

BOND BEAM CORNER DETAIL HYDROSTATIC VALVE MAIN DRAIN MAIN DRAIN DETAIL POOL DETAIL Pool Safety Fence & Gate Min 1.2m high in Accordance with -AS1926, BCA Part H7D2 Standards & Manufacturers Details. 1.8m Boundary fence -Proposed pool in Accordance with AS1926, BCA Part H7D2 Standards & Engineers Details

There must be an appropriate warning sign, including details of resuscitation (CPR) techniques, in the immediate vicinity of the pool area and which can be easily read from a distance of 3 metres

- Metal pool fence spigots to be earthed in accordance with AS/NZS3000:2007 Section 5.6.2.5 & 5.6.2.6
- For resuscitation purposes, ensure there is a space measuring 2.0m x 2.0m clear of all obstructions located adjacent to at least one pool access point

TYPICAL STAIR SECTION


AREA, ARE TO BE 1.2m ABOVE ANY EXTERNAL FOOT


IN ACCORDANCE WITH AS1926, BCA Part H7D2 STANDARDS


Swimming Pool

IF REQUIRED

ANY FENCE TO THE POOL

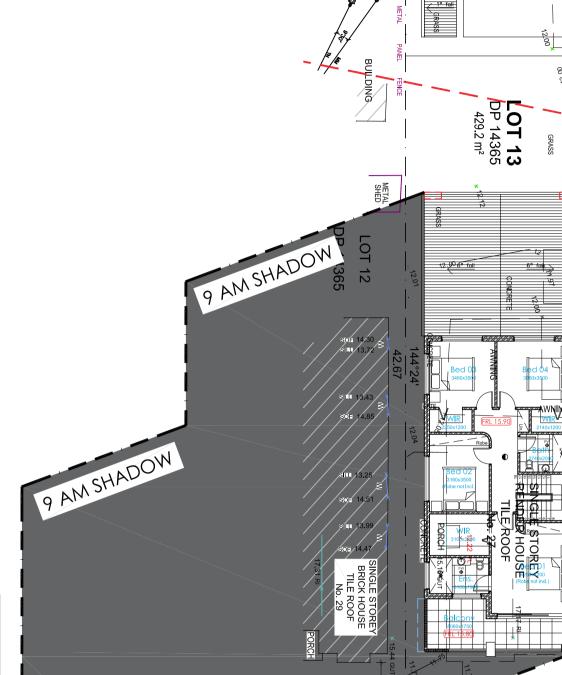

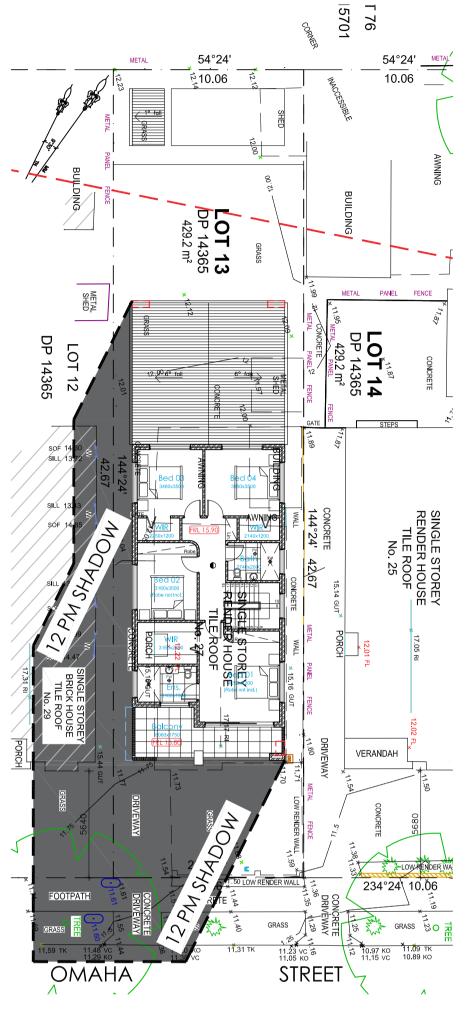

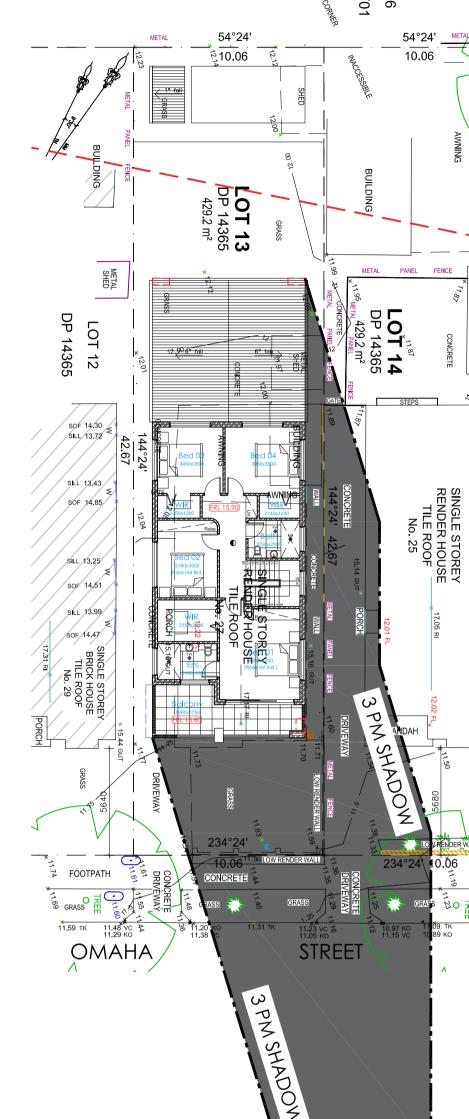



SHADOW DIAGRAM (3 PM SHADOW) **SCALE 1:200**


SUMMER SUN SET

SHADOW DIAGRAM - JUNE 22



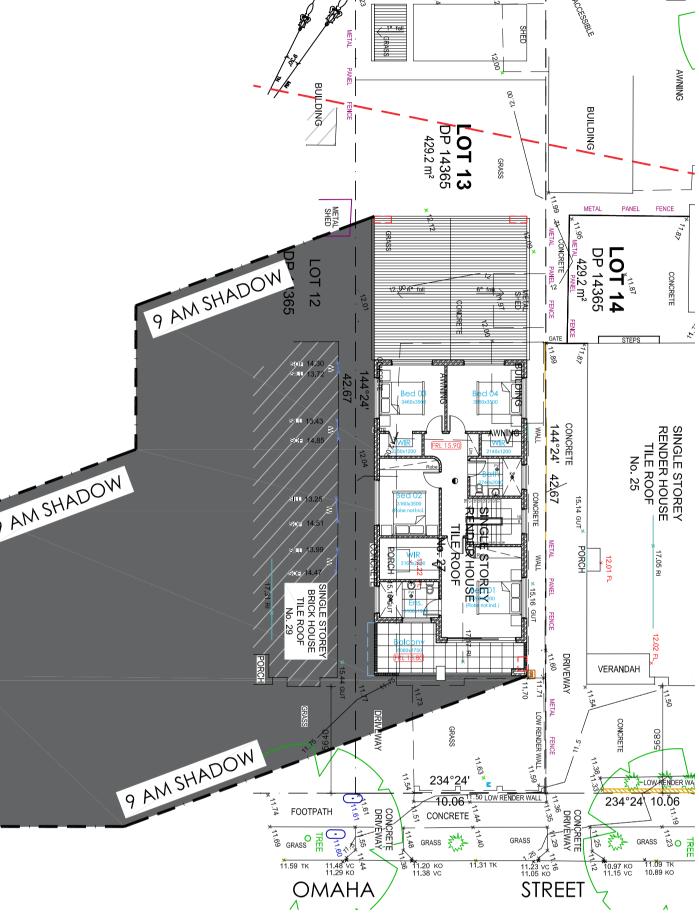

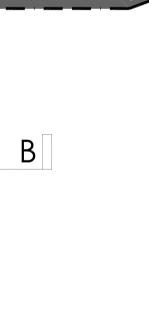

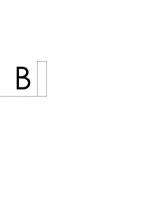




Pool Safety Fence & Gate Min 1.2m high in Accordance with AS1926, BCA Part H7D2 Standards & Manufacturers Details.

1.8m Boundary fence

Proposed pool in Accordance with AS1926, BCA Part H7D2 Standards & Engineers Details

> Hydrostatic relief valve

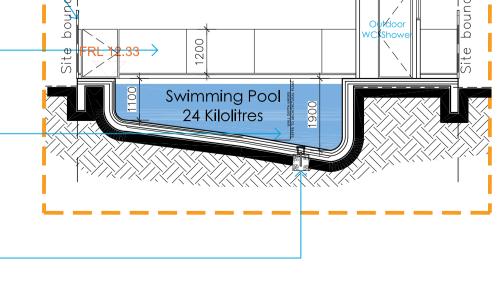


POOL SECTION B-B SCALE 1:100

SHADOW DIAGRAM (9 AM SHADOW)

SCALE 1:200



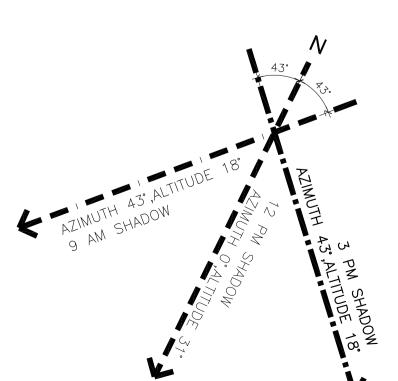

Designed By: s y d n e y

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Address:

27 Omaha Street,




Project: Demolition of Existing Structures, Proposed Construction of 2 Storey Dwelling Above Basement, Swimming Pool and Front Fence

Title: Shadow Diagrams, Section B-B and Pool Details

Council:

Canterbury-Bankstown Council DA DRAWINGS

| Drawn: | D a | te: | Proje | ct N |
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| A.T | 20.0 | 9.24 | 21-2 | 2023 |
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A.T 20.09.24

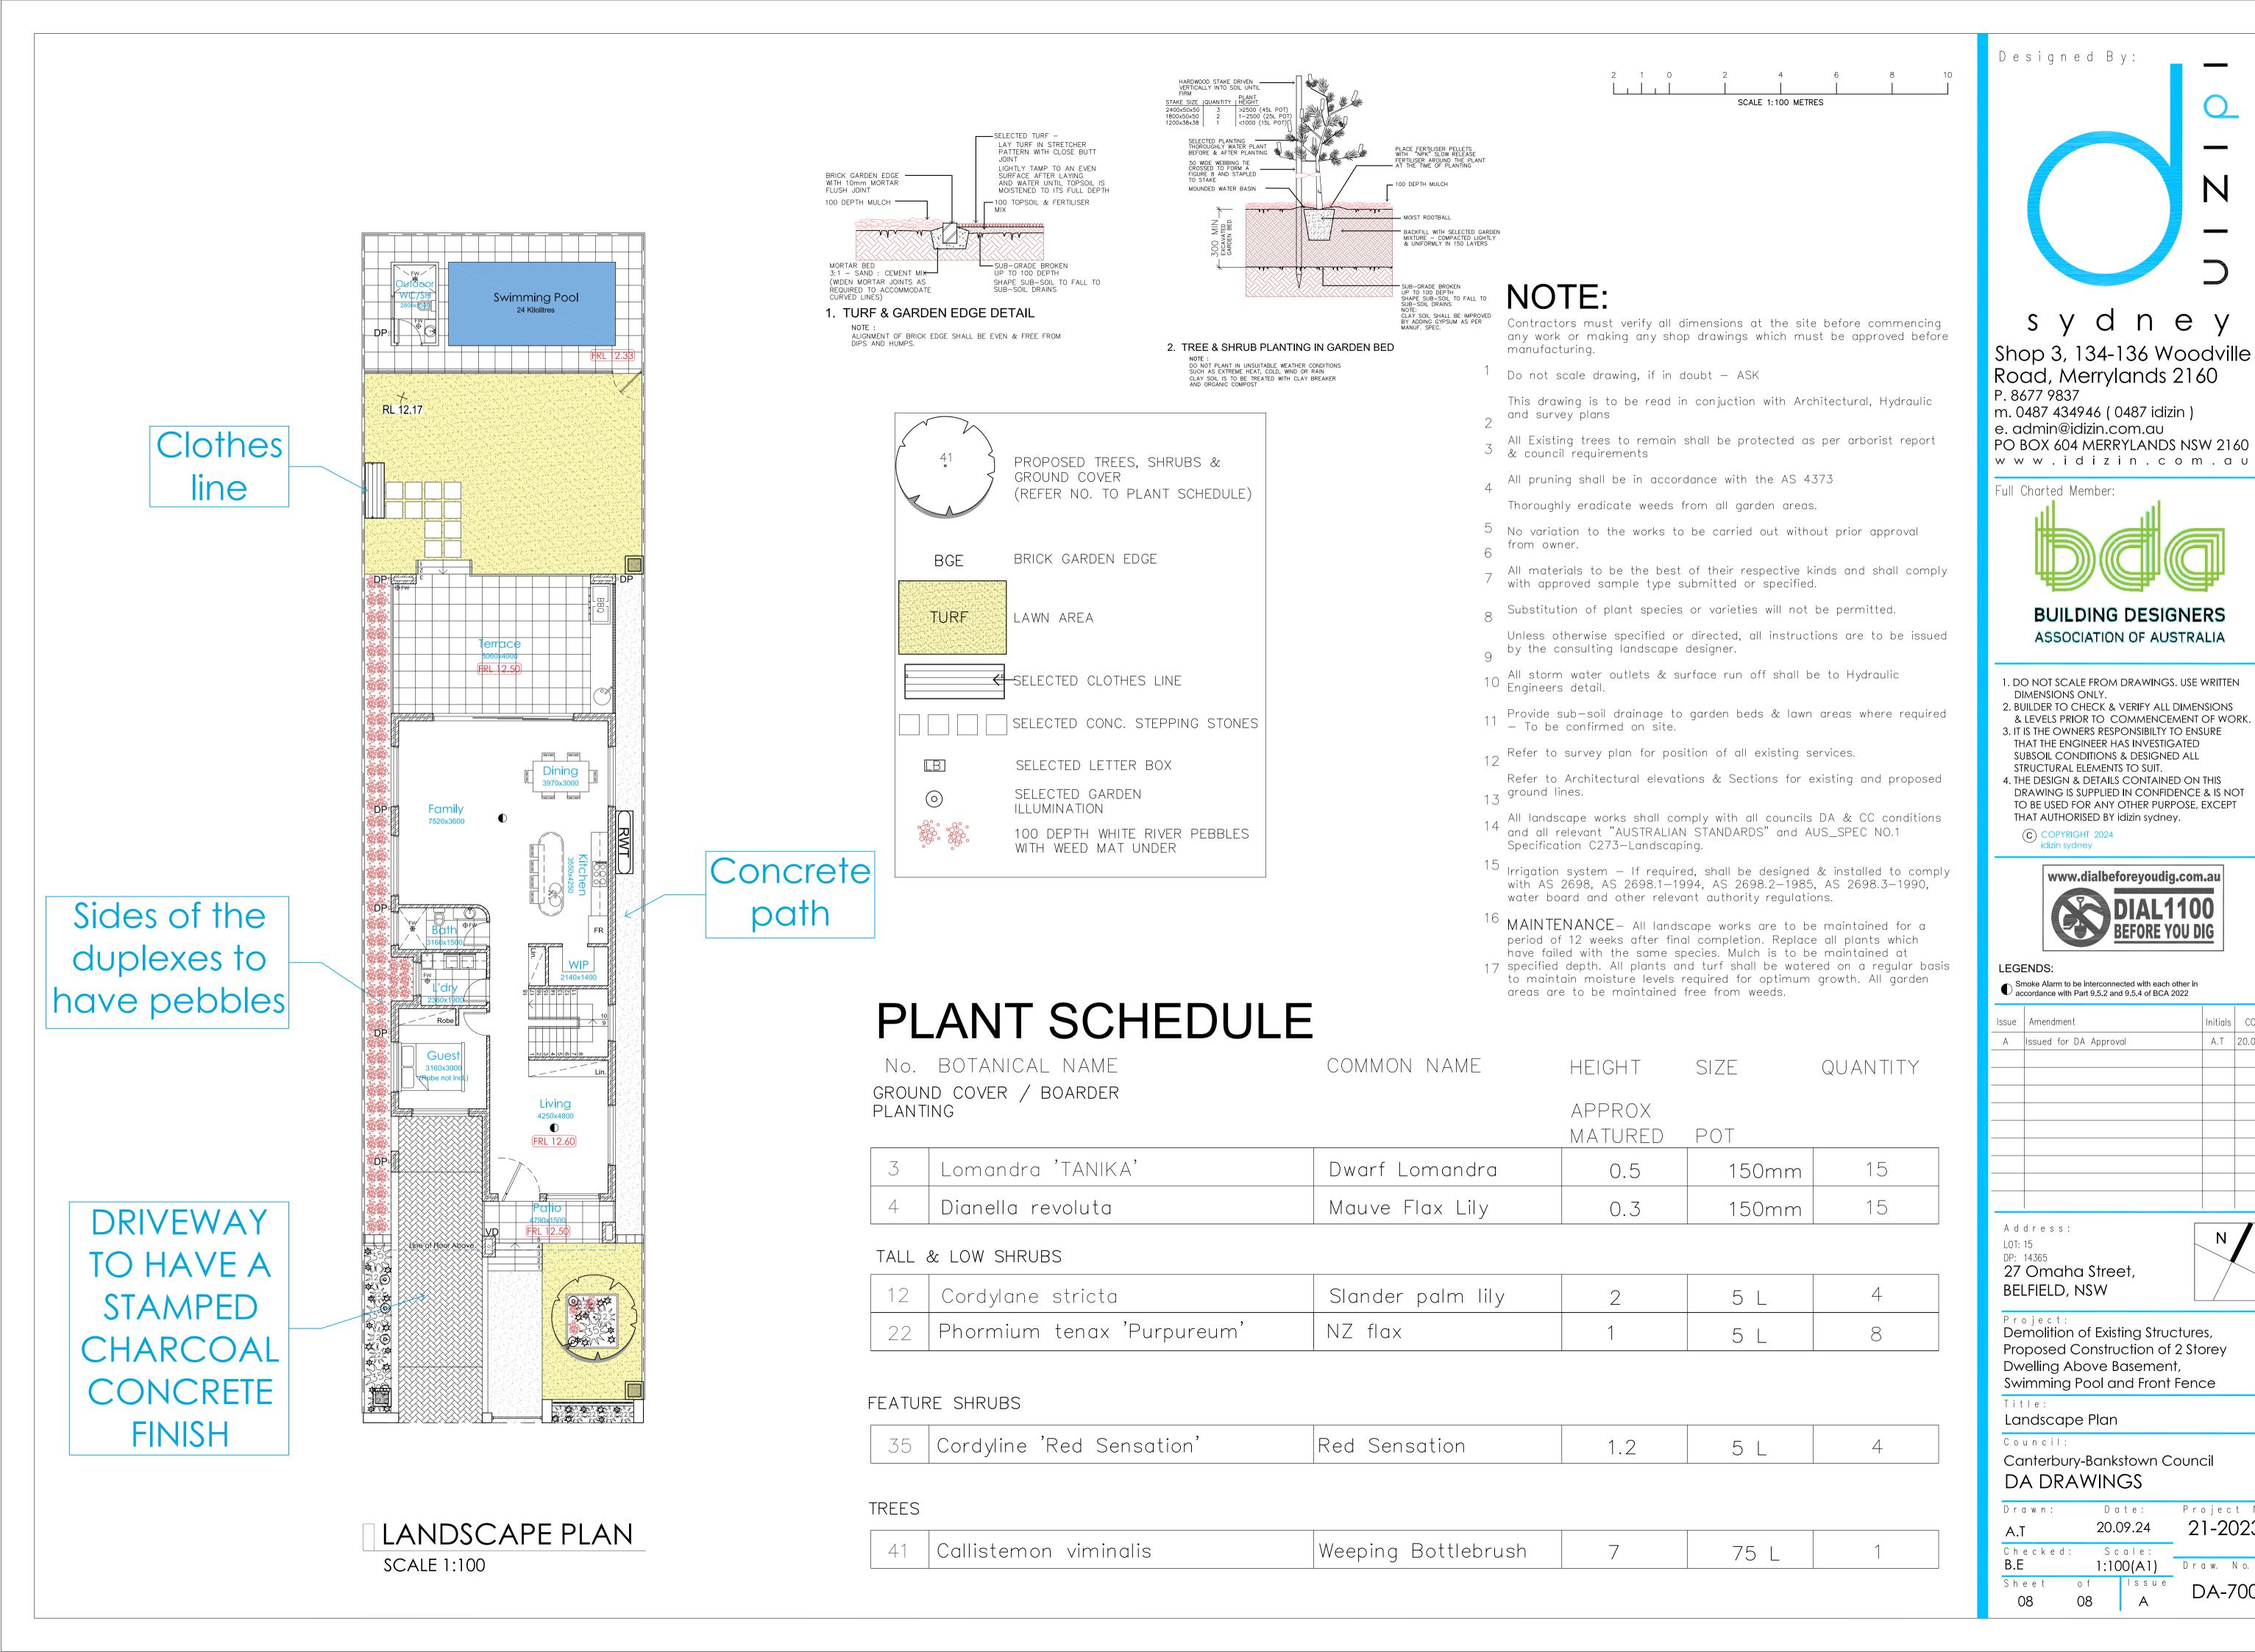Project No.

21-2023

DA-700

Draw. No.